
BAHIA VISTA ELEMENTARY SCHOOL -ROOFING UPGRADE AND IMPROVEMENTS

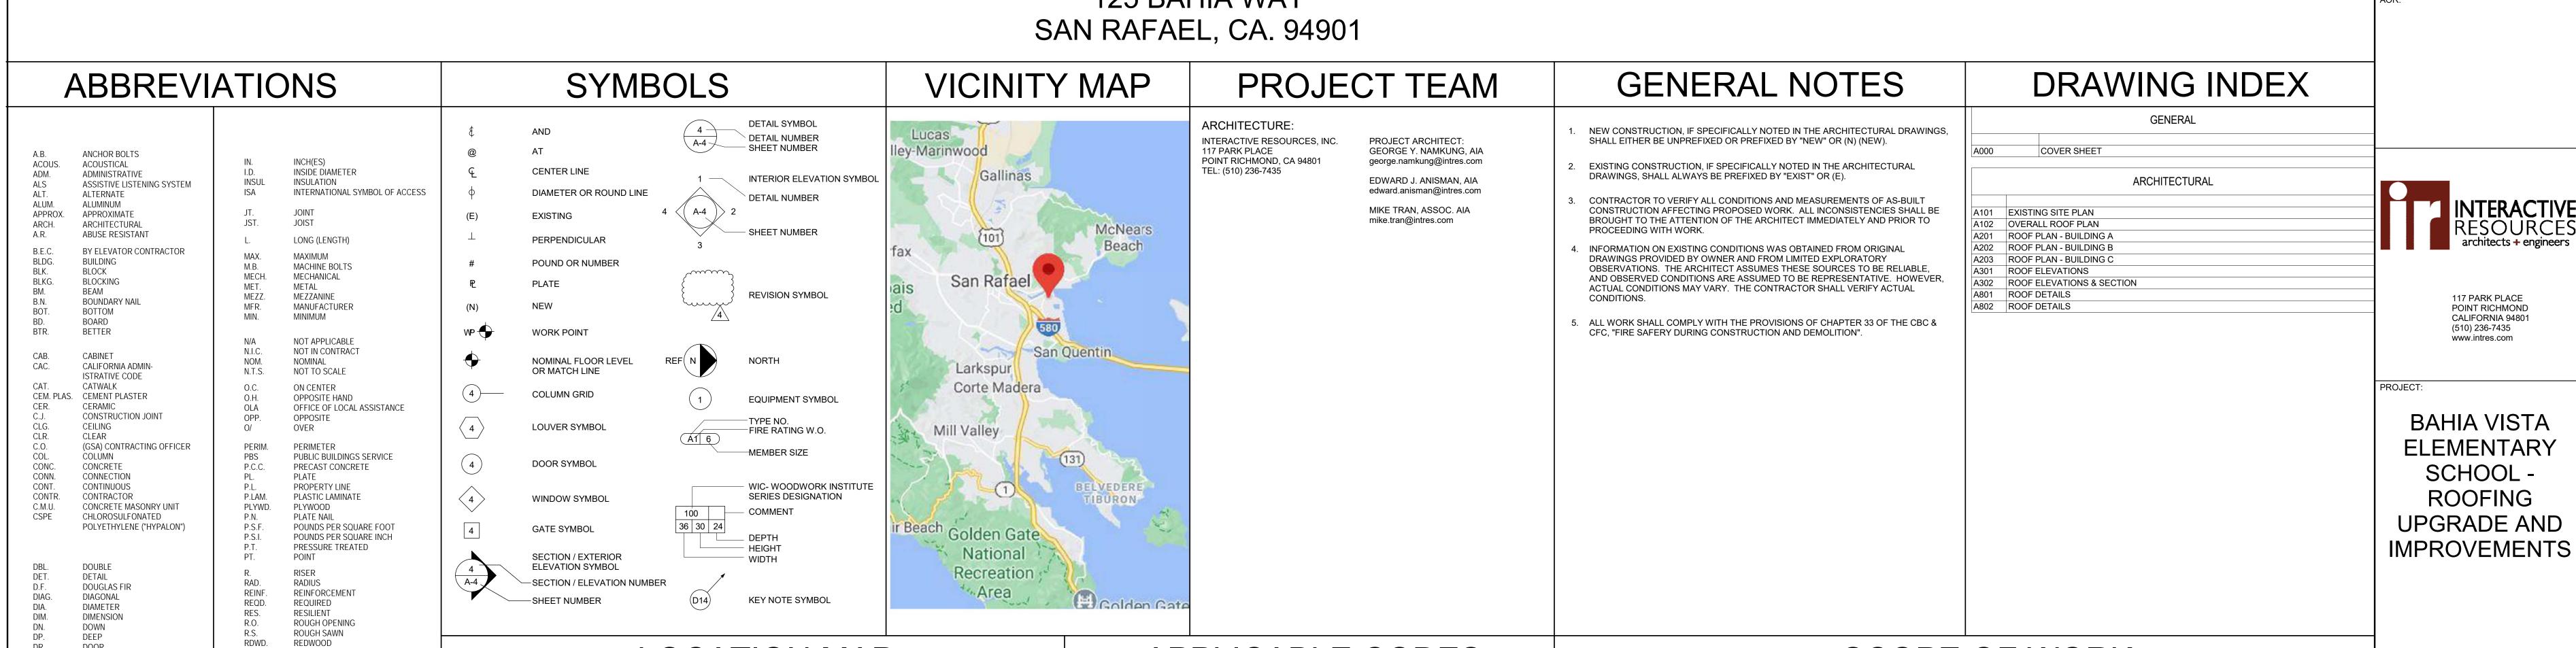





DOOR

DOWNSPOUT

EACH FACE

ELEVATION

ELECTRICAL

EDGE NAIL

EQUIPMENT

EACH SIDE

EACH WAY

EXISTING

EXTERIOR

EXPANSION

FOUNDATION

FLOOR JOIST

FLUORESCENT

FACE OF CONCRETE

FACE OF MASONRY

FACE OF FINISH

FACE OF STUD

FRAMING

FOOT/FEET

GALLON

GRADE

GALVANIZED

GALVANIZED SHEET STELL

GLUE LAMINATED BEAM

HAZARDOUS MATERIALS

HIGH STRENGTH BOLTS

GENERAL SERVICES

ADMINISTRATION

G.S.M. GALVANIZED SHEET METAL

ABATEMENT

HORIZONTAL

HEIGHT

HEADER

HOLLOW METAL

GYP. BD. GYPSUM BOARD

FIELD NAIL

FLOOR

FINISH FLOOR ELEVATION

E.W.

FLUOR.

F.O.M.

FRMG.

H.S.B.

EXPANSION JOIN

DIVISION OF THE STATE

ROUGH

RAIN WATER LEADER

SEE CIVIL DRAWINGS

SINGLE HUNG

SLAB ON GRADE

STAINLESS STELI

TOP AND BOTTOM

TOP OF CONCRETE

TOP OF PLATE LINE

TOP OF SUBFLOOR

TACKABLE WALL SURFACE

(FABRIC WRAPPED PANEL)

UNLESS OTHERWISE NOTED

TOP OF STEEL

TOP OF WALL

TRANSVERSE

TREATED

TYPICAL

VERTICAL

WASHER

WITHOUT

CROSS

WATERPROOF

VERTICAL GRAIN

WATER CLOSET WOOD

WHERE OCCURS

WEATHERPROOF

WOOD SCREW

WELDED WIRE MESH

WEATHER RESISTANT BARRIER

TONGUE AND GROOVE

STANDARD STEEL PIPE

SPECIFICATION(S)

SIMILAR

SQUARE

STRUCTURAL

SYMMETRICAL

TOP OF CURB

TELEPHONE

TERRAZZO

SLIDER

SUSPENDED ACOUSTICAL

SELF ADHERED FLASHING

SEE ELECTRICAL DRAWINGS

SEE LANDSCAPE DRAWINGS

SEE MECHANICAL DRAWINGS

SEE MECHANICAL DRAWINGS

SHEET METAL SCREW(S)

SEE STRUCTURAL DRAWINGS

R.W.L.

S.C.D.

S.M.D.

S.S.D.

S.H.

SLDR.

S.O.G.

STRUC.


T.O.PL.

T.O.S.

T.O.SF.

T.O.W.

SYM.

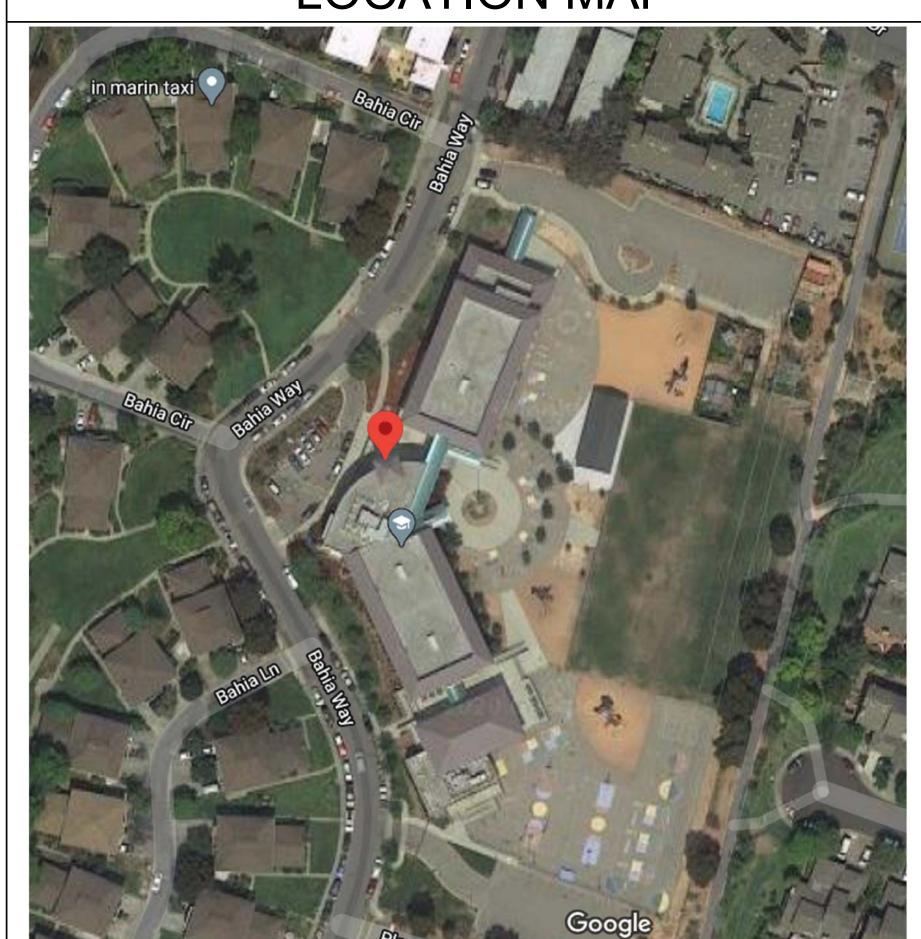

APPLICABLE CODES

PART 1 - CALIFORNIA BUILDING STANDARDS ADMINISTRATIVE CODE PART 2 - CALIFORNIA BUILDING CODE PART 2.5 - CALIFORNIA RESIDENTIAL BUILDING CODE

PART 3 - CALIFORNIA ELECTRICAL CODE PART 4 - CALIFORNIA MECHANICAL CODE

PART 5 - CALIFORNIA PLUMBING CODE PART 6 - CALIFORNIA ENERGY CODE PART 8 - CALIFORNIA HISTORICAL BUILDING CODE

PART 9 - CALIFORNIA FIRE CODE PART 10 - CALIFORNIA EXISTING BUILDING CODE PART 11 - CALIFORNIA GREEN BUILDING STANDARDS CODE PART 12 - CALIFORNIA REFERENCE STANDARDS CODE

PROJECT DATA

310 NOVA ALBION WAY SAN RAFAEL, CA 94903 (415) 492-3200 EMAIL: communications @ srcs.org

9,764 SF.

31'-6"

18,671 SF.

TYPE V-A

FULLY SPRINKLERED

(E) BUILDING A:

OCCUPANCY: A-2 CONST. TYPE: FIRE PROTECTION: FULLY SPRINKLERED (E) BUILDING B:

LEVEL 2: TOTAL AREA: HEIGHT: OCCUPANCY: CONST. TYPE: FIRE PROTECTION:

(E) BUILDING C: **BUILDING AREA:** LEVEL 1: TOTAL AREA: OCCUPANCY: CONST. TYPE: FIRE PROTECTION:

8,635 SF. 19,115 SF. 19'-0" TYPE V-A FULLY SPRINKLERED

SCOPE OF WORK

PROJECT SUMMARY:
A GENERAL SUMMARY OF THE PROPOSED SCOPE INCLUDES – BUT IS NOT LIMITED TO – THE

1. PREPARE FIELD OF ROOF TO RECEIVE NEW SILICONE ROOF COATING; AND APPLY COATING

2. REMOVE AND REPLACE LOW PARAPET COPING. 3. HIGH METAL ROOFING TO REMAIN.

 PREPARE FIELD OF ROOF TO RECEIVE NEW SILICONE ROOF COATING; AND APPLY COATING. REMOVE AND REPLACE LOW PARAPET COPING; PROVIDE SILICONE TAPE AT JOINTS. 3. HIGH METAL ROOFING TO REMAIN.

4. POWER WASH HIGH PARAPET WALL FINISH, REMOVE (E) PLASTER FINISH COAT WHERE FINISH COAT IS NOT FULLY ADHERED AND APPLY ACRYLIC STUCCO COATING OVER (E) FINISH. PARAPET WALL.ACRYLIC STUCO COATING. 5. REMOVE ALL SEALANT AT EXISTING ACCESS DOOR AND LOUVERS AT PARAPET WALL AND RE-

6. HIGH METAL ROOFING TO REMAIN. 7. REPLACE SHEET FLASHING AT METAL ROOF.

1. PREPARE FIELD OF ROOF TO RECEIVE NEW SILICONE ROOF COATING; AND APPLY COATING. 2. REMOVE AND REPLACE LOW PARAPET COPING 3. HIGH METAL ROOFING TO REMAIN.

4. POWER WASH HIGH PARAPET WALL FINISH, REMOVE (E) PLASTER FINISH COAT WHERE FINISH COAT IS NOT FULLY ADHERED AND APPLY ACRYLIC STUCCO COATING OVER (E) FINISH 5. REMOVE ALL SEALANT AT EXISTING ACCESS DOOR AND LOUVERS AT PARAPET WALL AND RE-

6. HIGH METAL ROOFING TO REMAIN. 7. REPLACE SHEET METAL FLASHING AT METAL ROOF

125 BAHIA WAY SAN RAFAEL, CA. 94901


| INITIAL | DATE

DESCRIPTION

ISSUED FOR PROGRESS REVIEW

SSUED FOR PLAN CHECK

SSUED FOR CONSTRUCTION

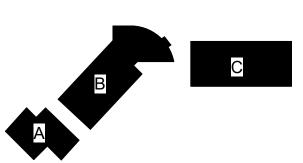




COVER SHEET

2020-036-01 PREPARATION AND REVIEW DESIGNER: PROJ MGR:

PEER REVIEW

SHEET NUMBER:

Checker

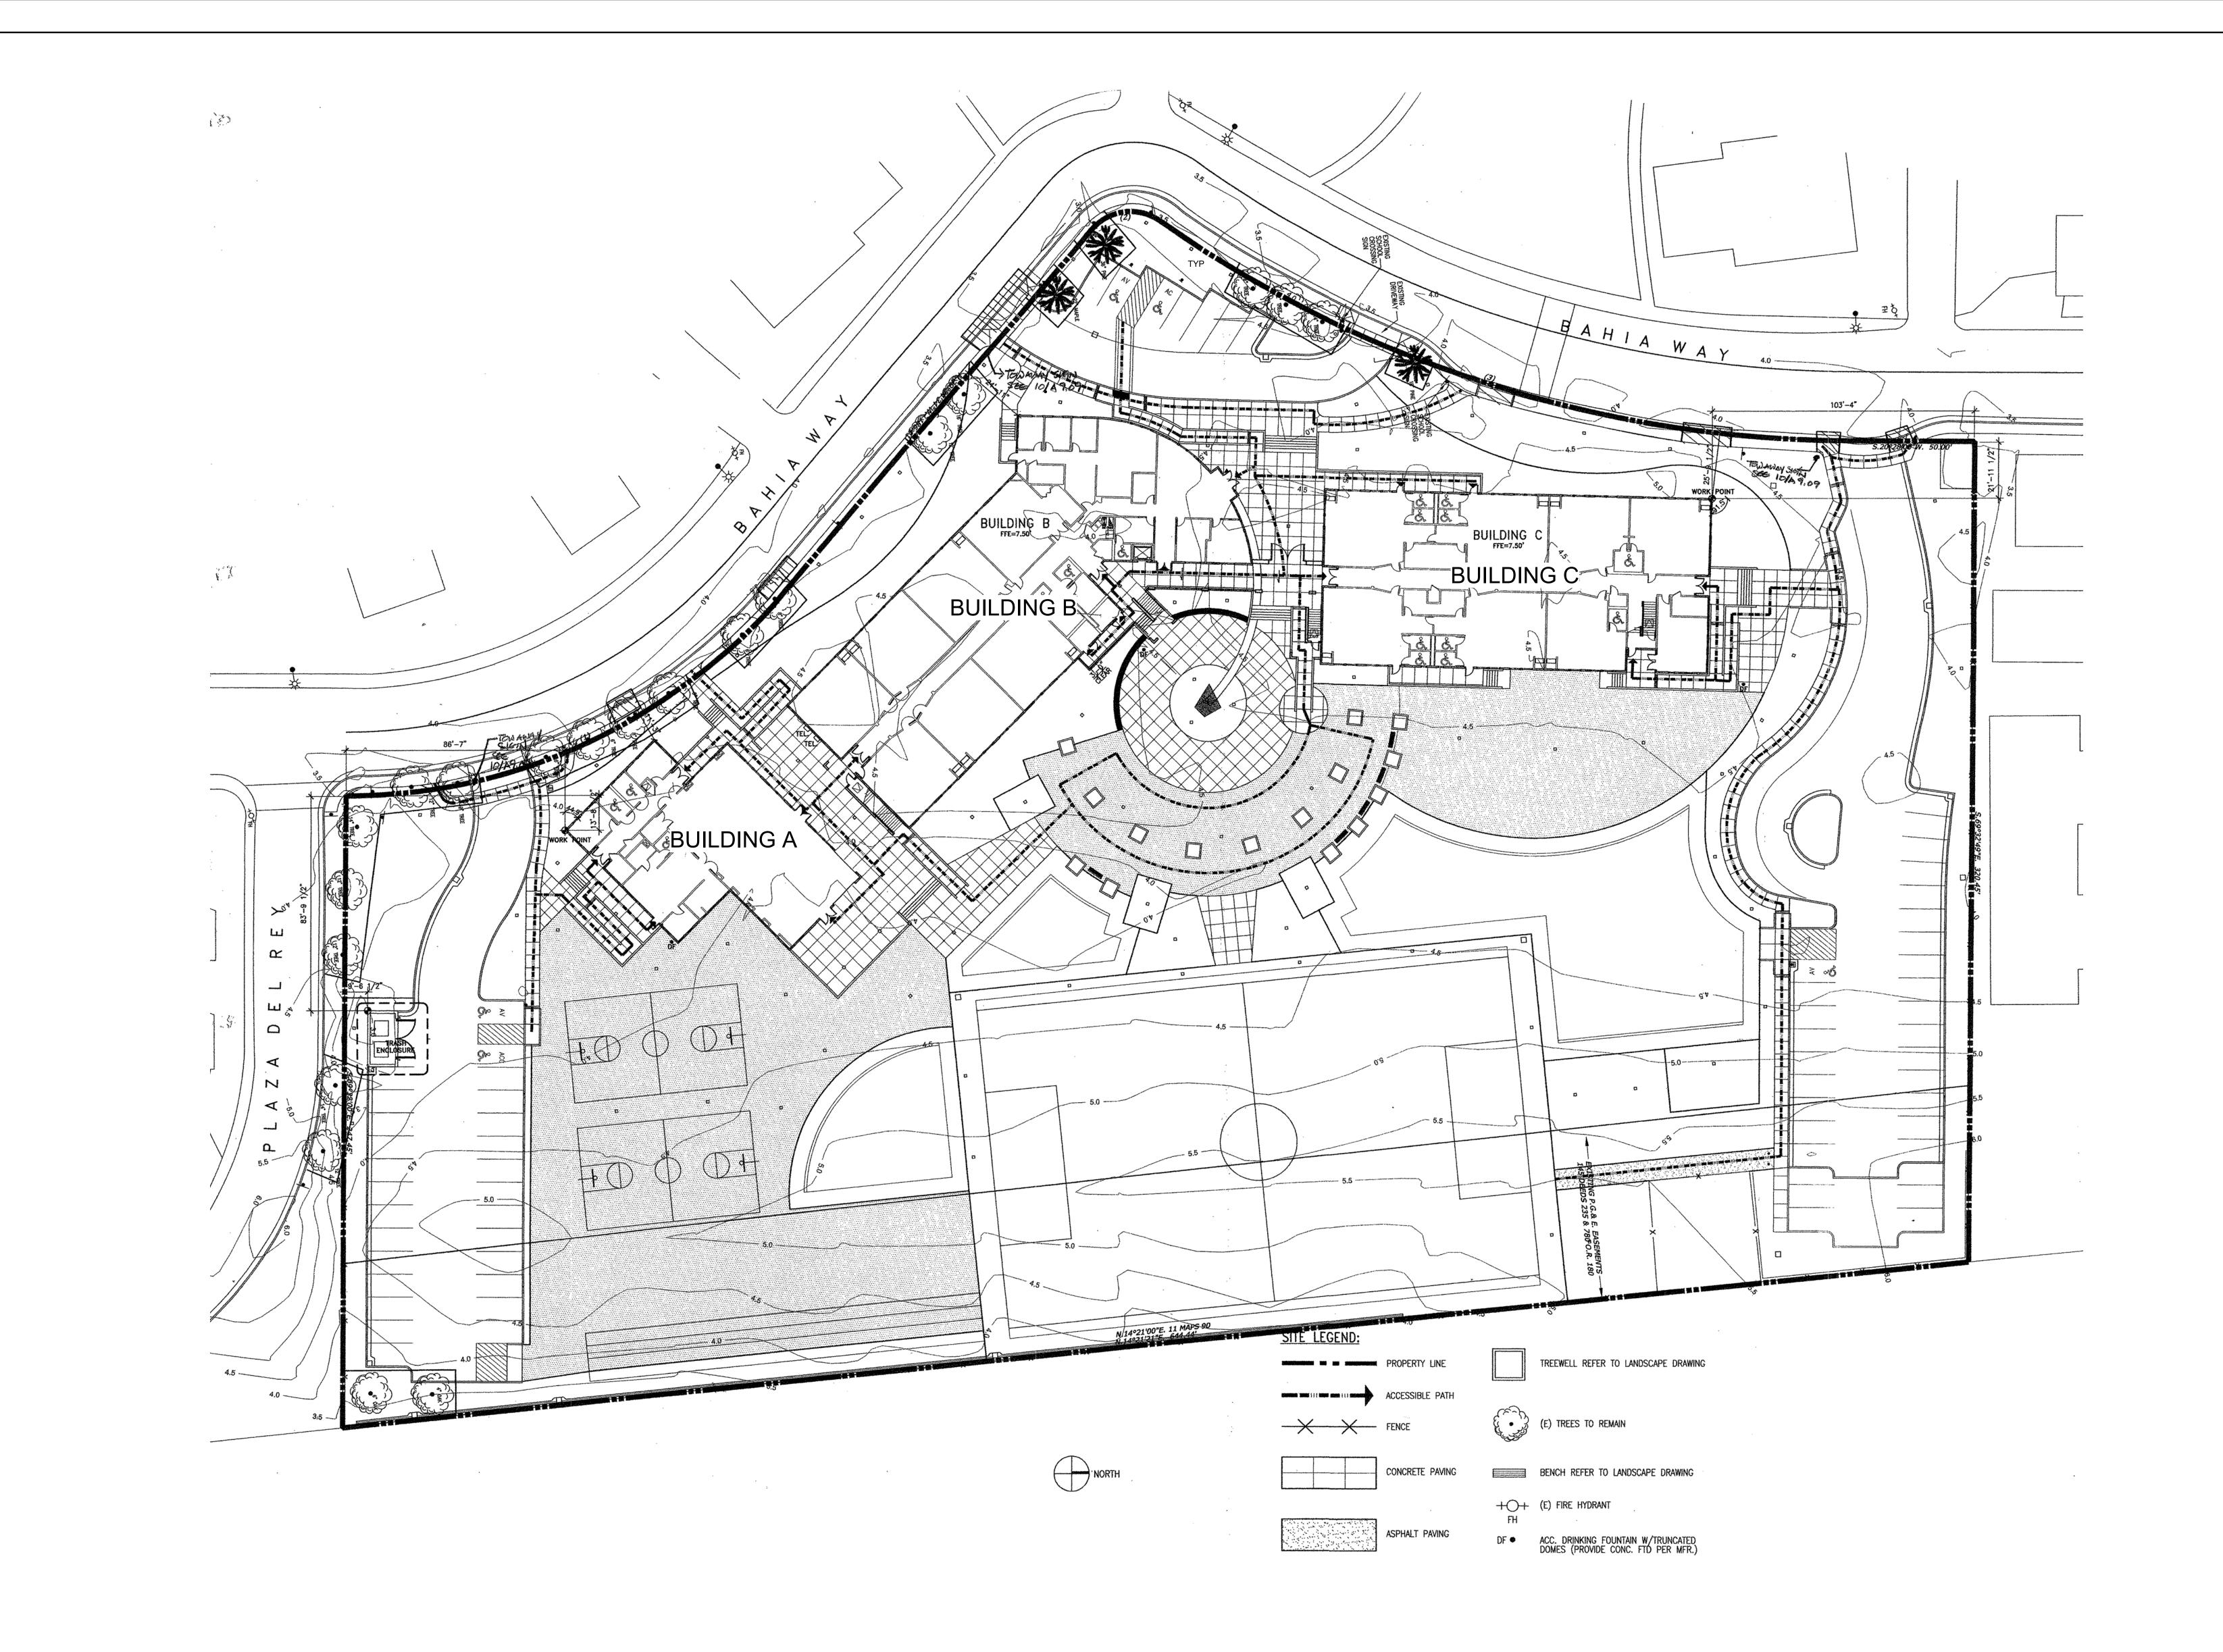

REVISION DESCRIPTION INITIAL DATE

ISSUED FOR PROGRESS REVIEW

ISSUED FOR PLAN CHECK

ISSUED FOR PERMIT

ISSUED FOR BID

O5/26/22

ISSUED FOR CONSTRUCTION

SEAL:

AOR:




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PROJECT:

BAHIA VISTA
ELEMENTARY
SCHOOL ROOFING
UPGRADE AND
IMPROVEMENTS

125 BAHIA WAY SAN RAFAEL, CA. 94901

KEY PLAN

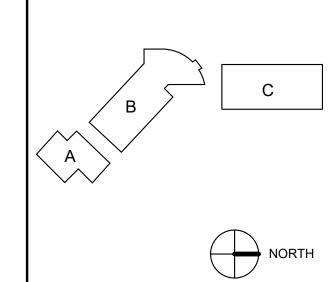

EXISTING SITE PLAN

PROJ. NO. 2020-036-01

PREPARATION AND REVIEW

DRAWN BY: MT

DESIGNER: GYN

PROJ MGR: AMB


PEER REVIEW

SHEET NUMBER:

A101

Checker

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REVISION DESCRIPTION INITIAL DATE

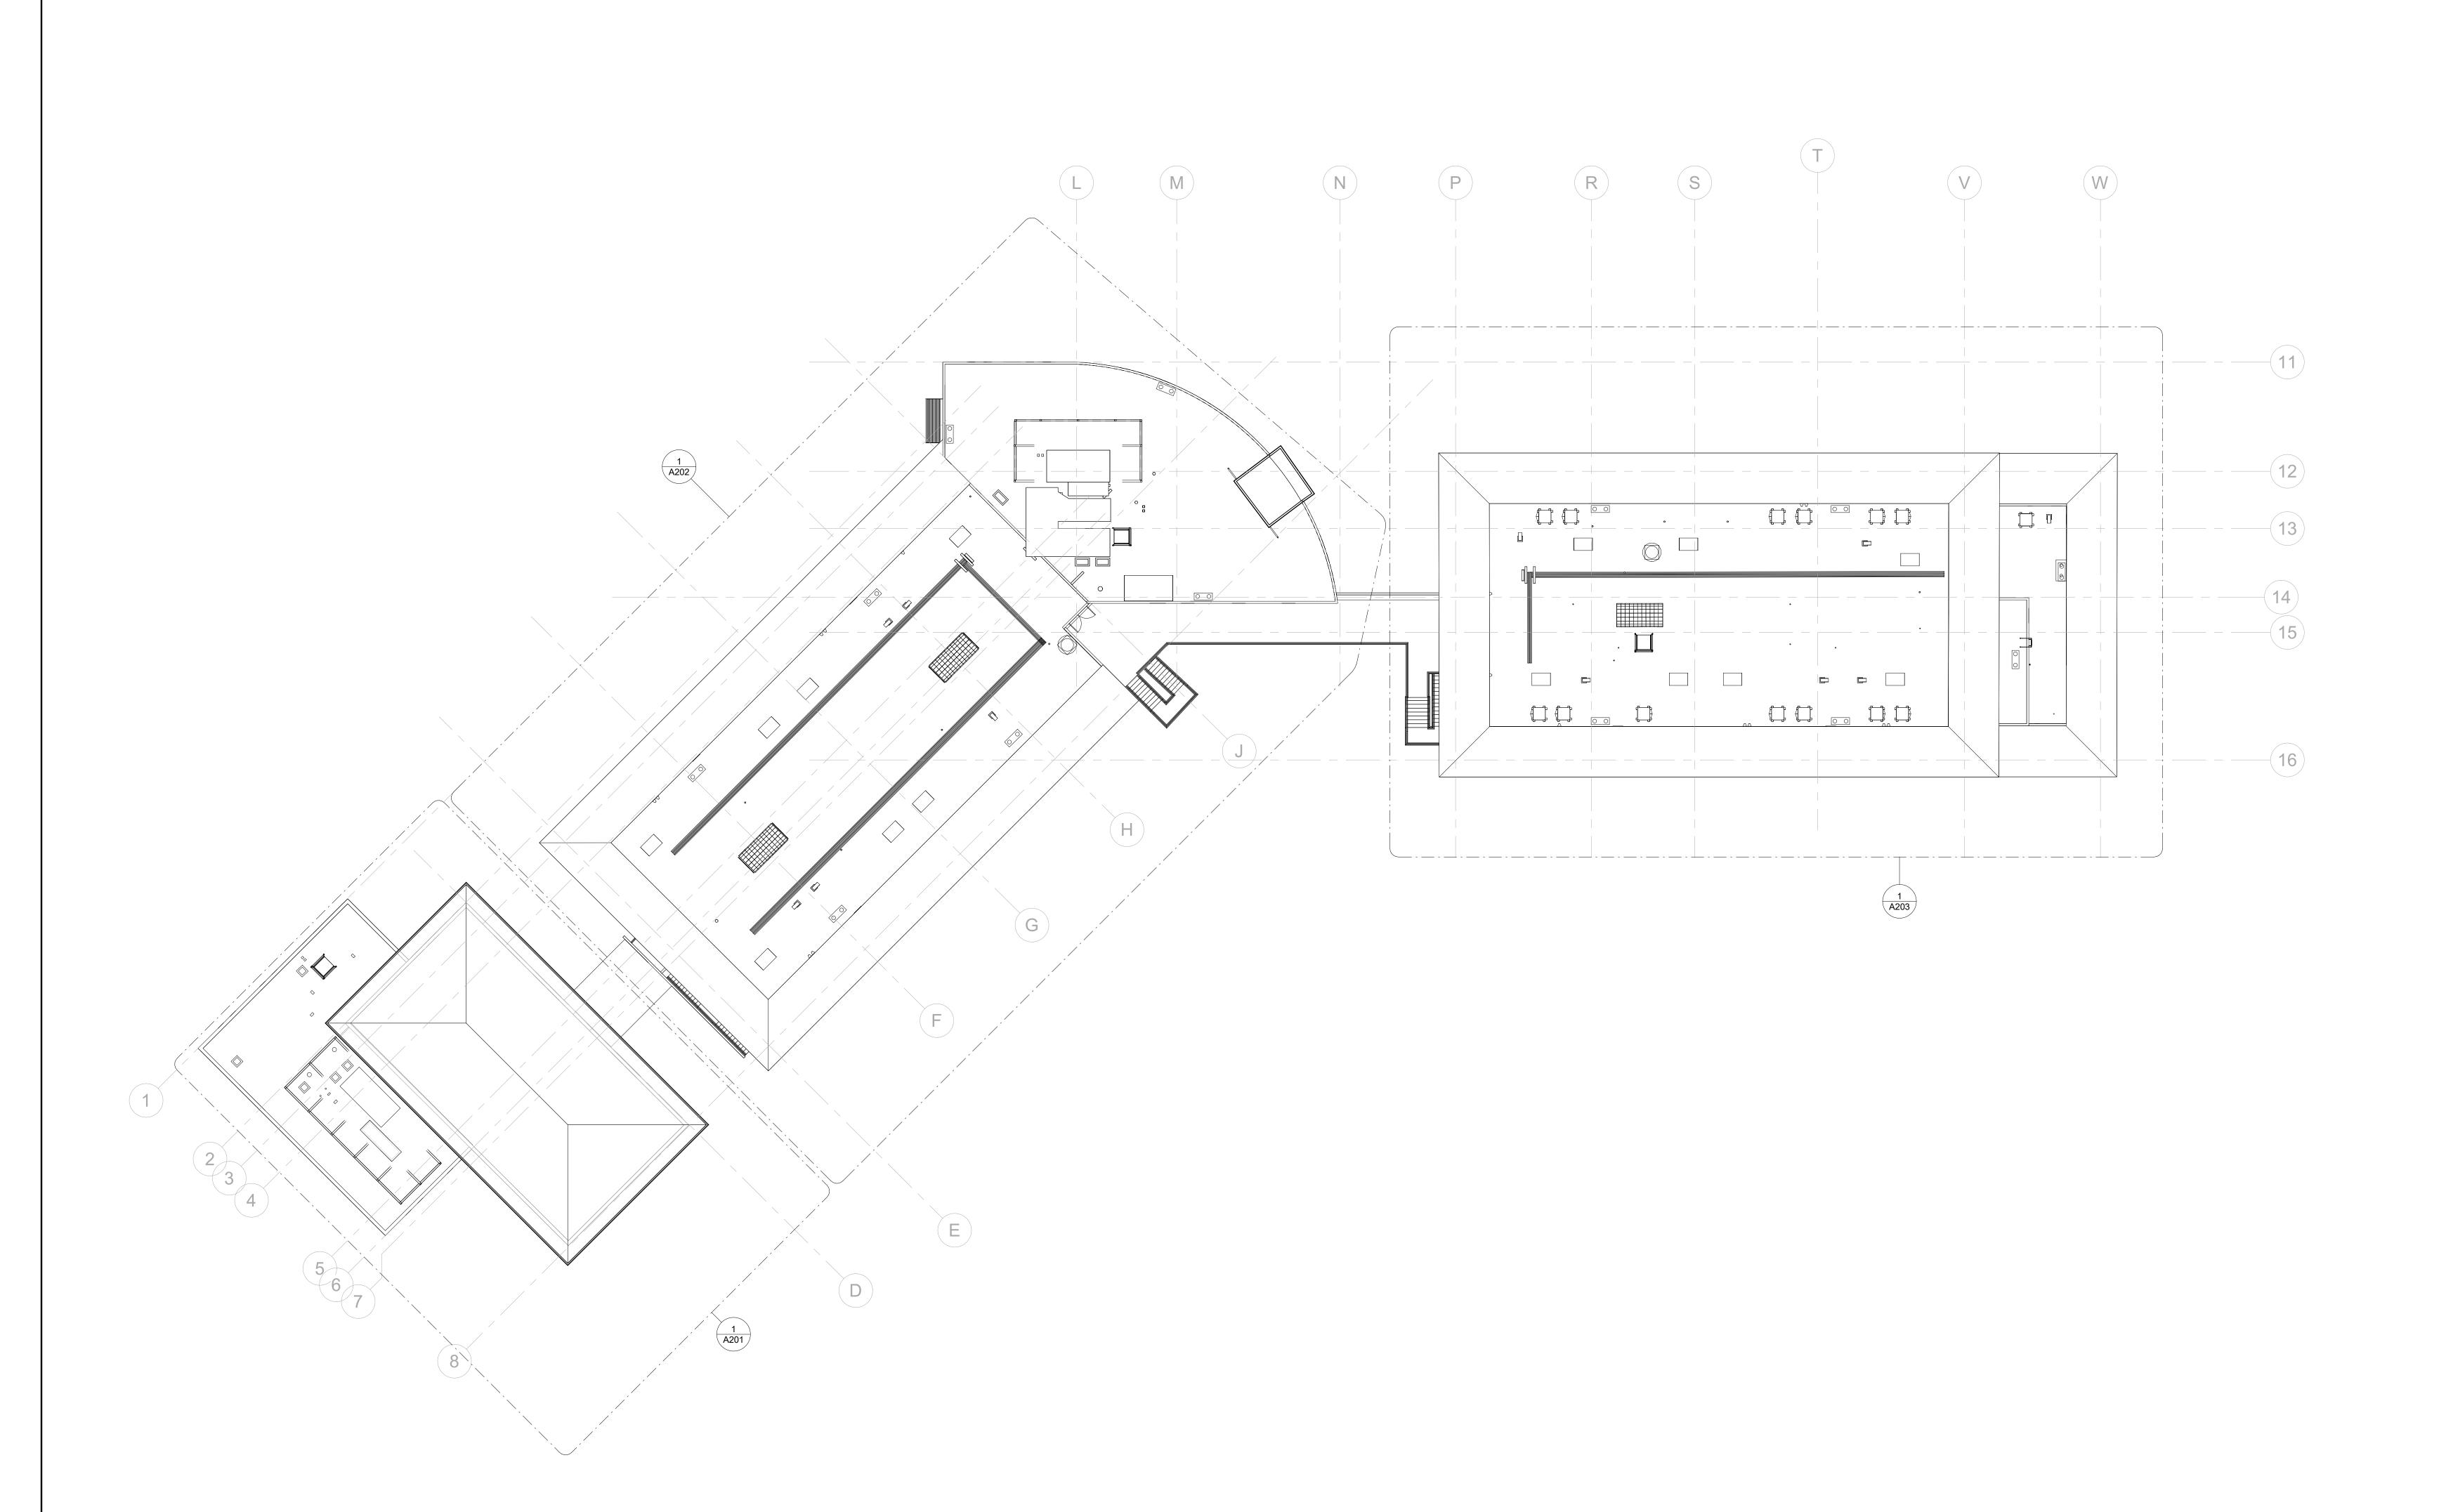ISSUED FOR PROGRESS REVIEW
ISSUED FOR PLAN CHECK
ISSUED FOR PERMIT
ISSUED FOR BID 05/26/22
ISSUED FOR CONSTRUCTION

AOR:

INTERACTIVE RESOURCES architects + engineers


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PROJECT

BAHIA VISTA
ELEMENTARY
SCHOOL ROOFING
UPGRADE AND
IMPROVEMENTS

125 BAHIA WAY SAN RAFAEL, CA. 94901

KEY PLAN

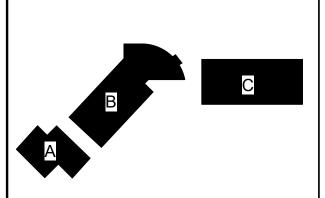

NORTH

OVERALL ROOF
PLAN

PROJ. NO. 2020-036-01

PREPARATION AND REVIEW

DRAWN BY: Author

DESIGNER: Designer


PROJ MGR: AMB

PEER REVIEW Checker

SHEET NUMBER:

A102

1 OVERALL ROOF PLAN
1/16" = 1'-0"

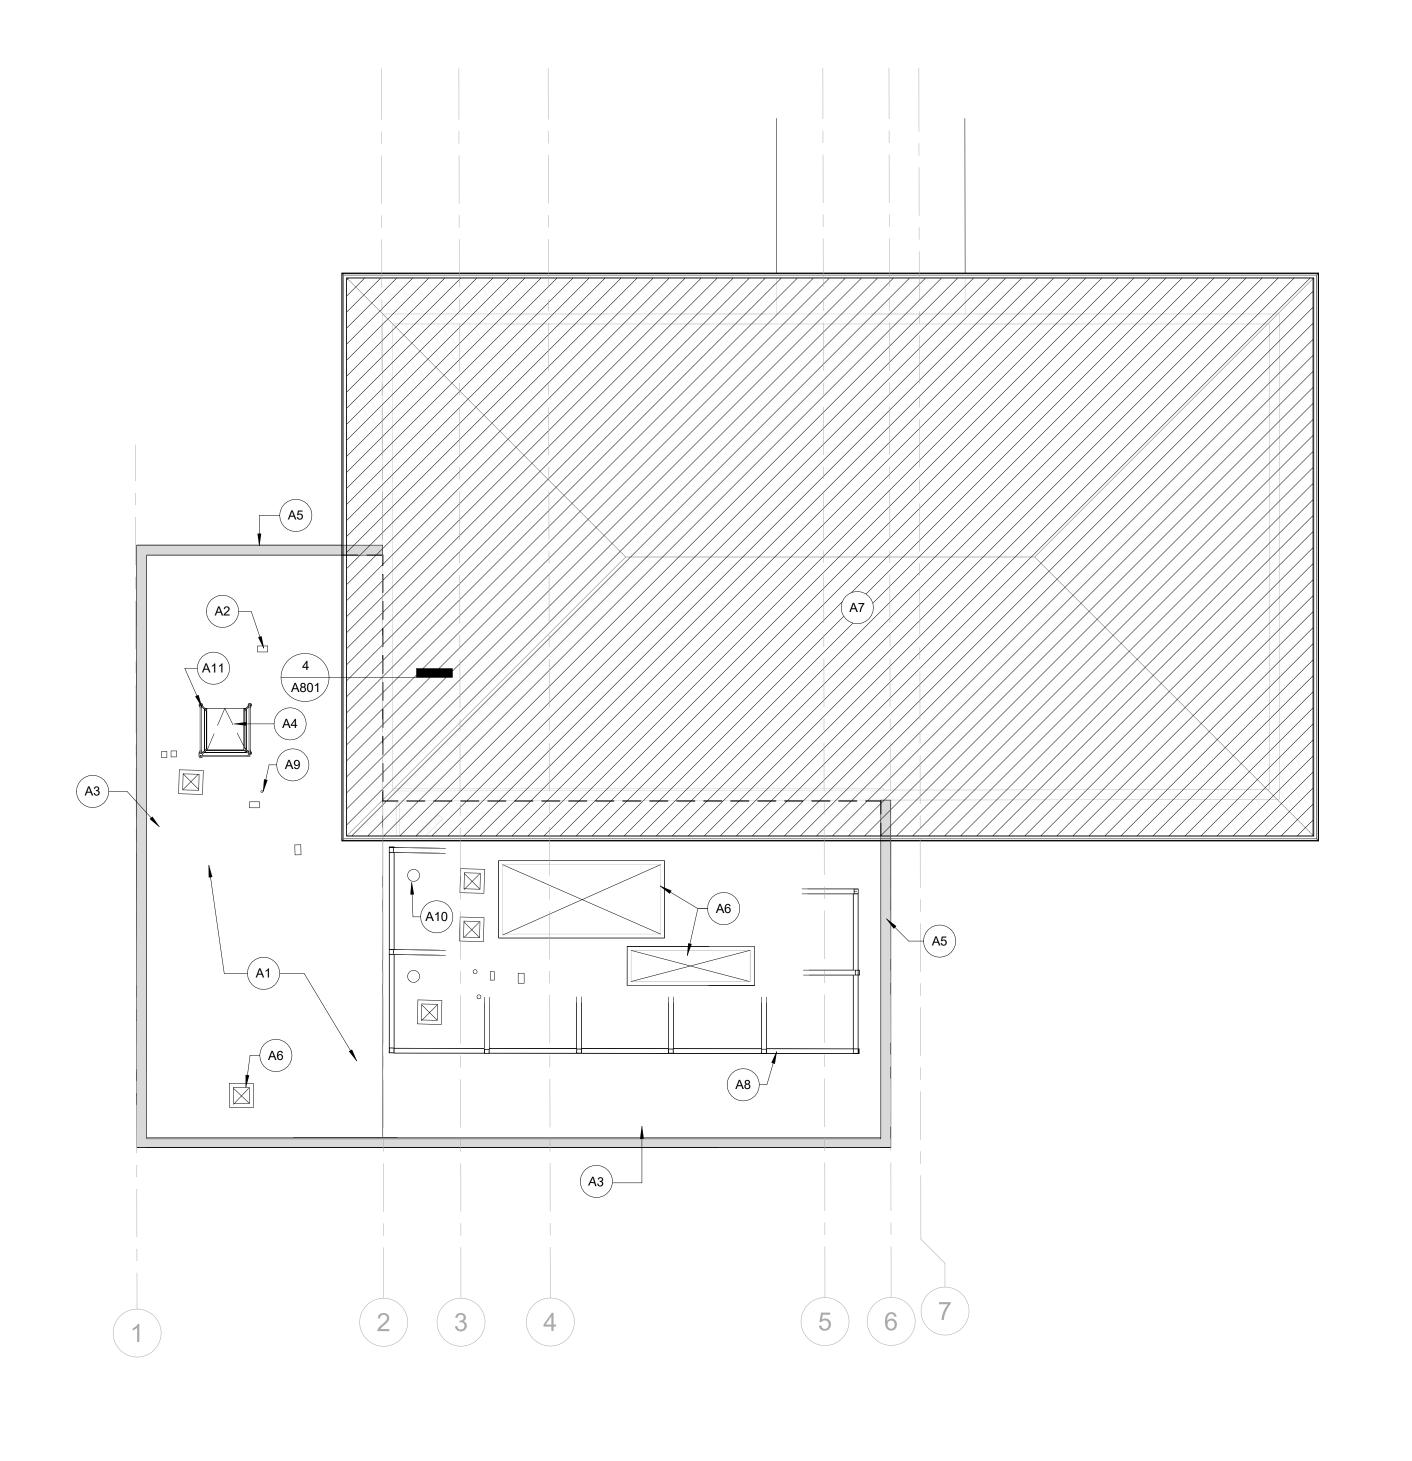



SILICONE ROOF COATING OVER ENTIRE (E) LOW SLOPED ROOF, TYP.

(E) SLEEPER SEE DETAIL 11 / A801

A11 ROOF HATCH GUARDRAIL 2 / A802

LEGEND:

(E) ROOF AND OVERFLOW DRAINS, TYP. SEE DETAIL 16 / A801

(E) ROOF HATCH TO REMAIN. REMOVE (E) LADDER EXTENSION. 3 / A802

(N) METAL COPING, TYP SEE DETAIL 2 / A801

(E) MECHANICAL UNIT AND CURB, TYP. 13 / A801

(E) METAL ROOFING, N.I.C.

(E) MECHANICAL SCREEN FRAME 5 / A802

(E) PIPE PENETRATION, TYP14 / A801

(E) VENT PENETRATION, TYP 5 / A801

METAL COPING AT LOW PARAPET

(E) METAL ROOF, N.I.C.

ISSUED FOR PROGRESS REVIEW

INITIAL DATE

REVISION DESCRIPTION

ISSUED FOR PLAN CHECK ISSUED FOR PERMIT ISSUED FOR BID ISSUED FOR CONSTRUCTION


INTERACTIVE RESOURCES architects + engineers

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BAHIA VISTA **ELEMENTARY** SCHOOL -ROOFING UPGRADE AND **IMPROVEMENTS**

125 BAHIA WAY SAN RAFAEL, CA. 94901

KEY PLAN

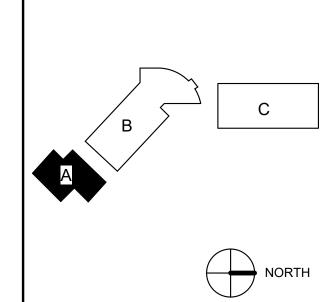


SHEET TITLE:

ROOF PLAN -BUILDING A

PROJ. NO. 2020-036-01 PREPARATION AND REVIEW DESIGNER: Designer PROJ MGR: PEER REVIEW Checker SHEET NUMBER:

ROOF PLAN - BUILDING A
1/8" = 1'-0"

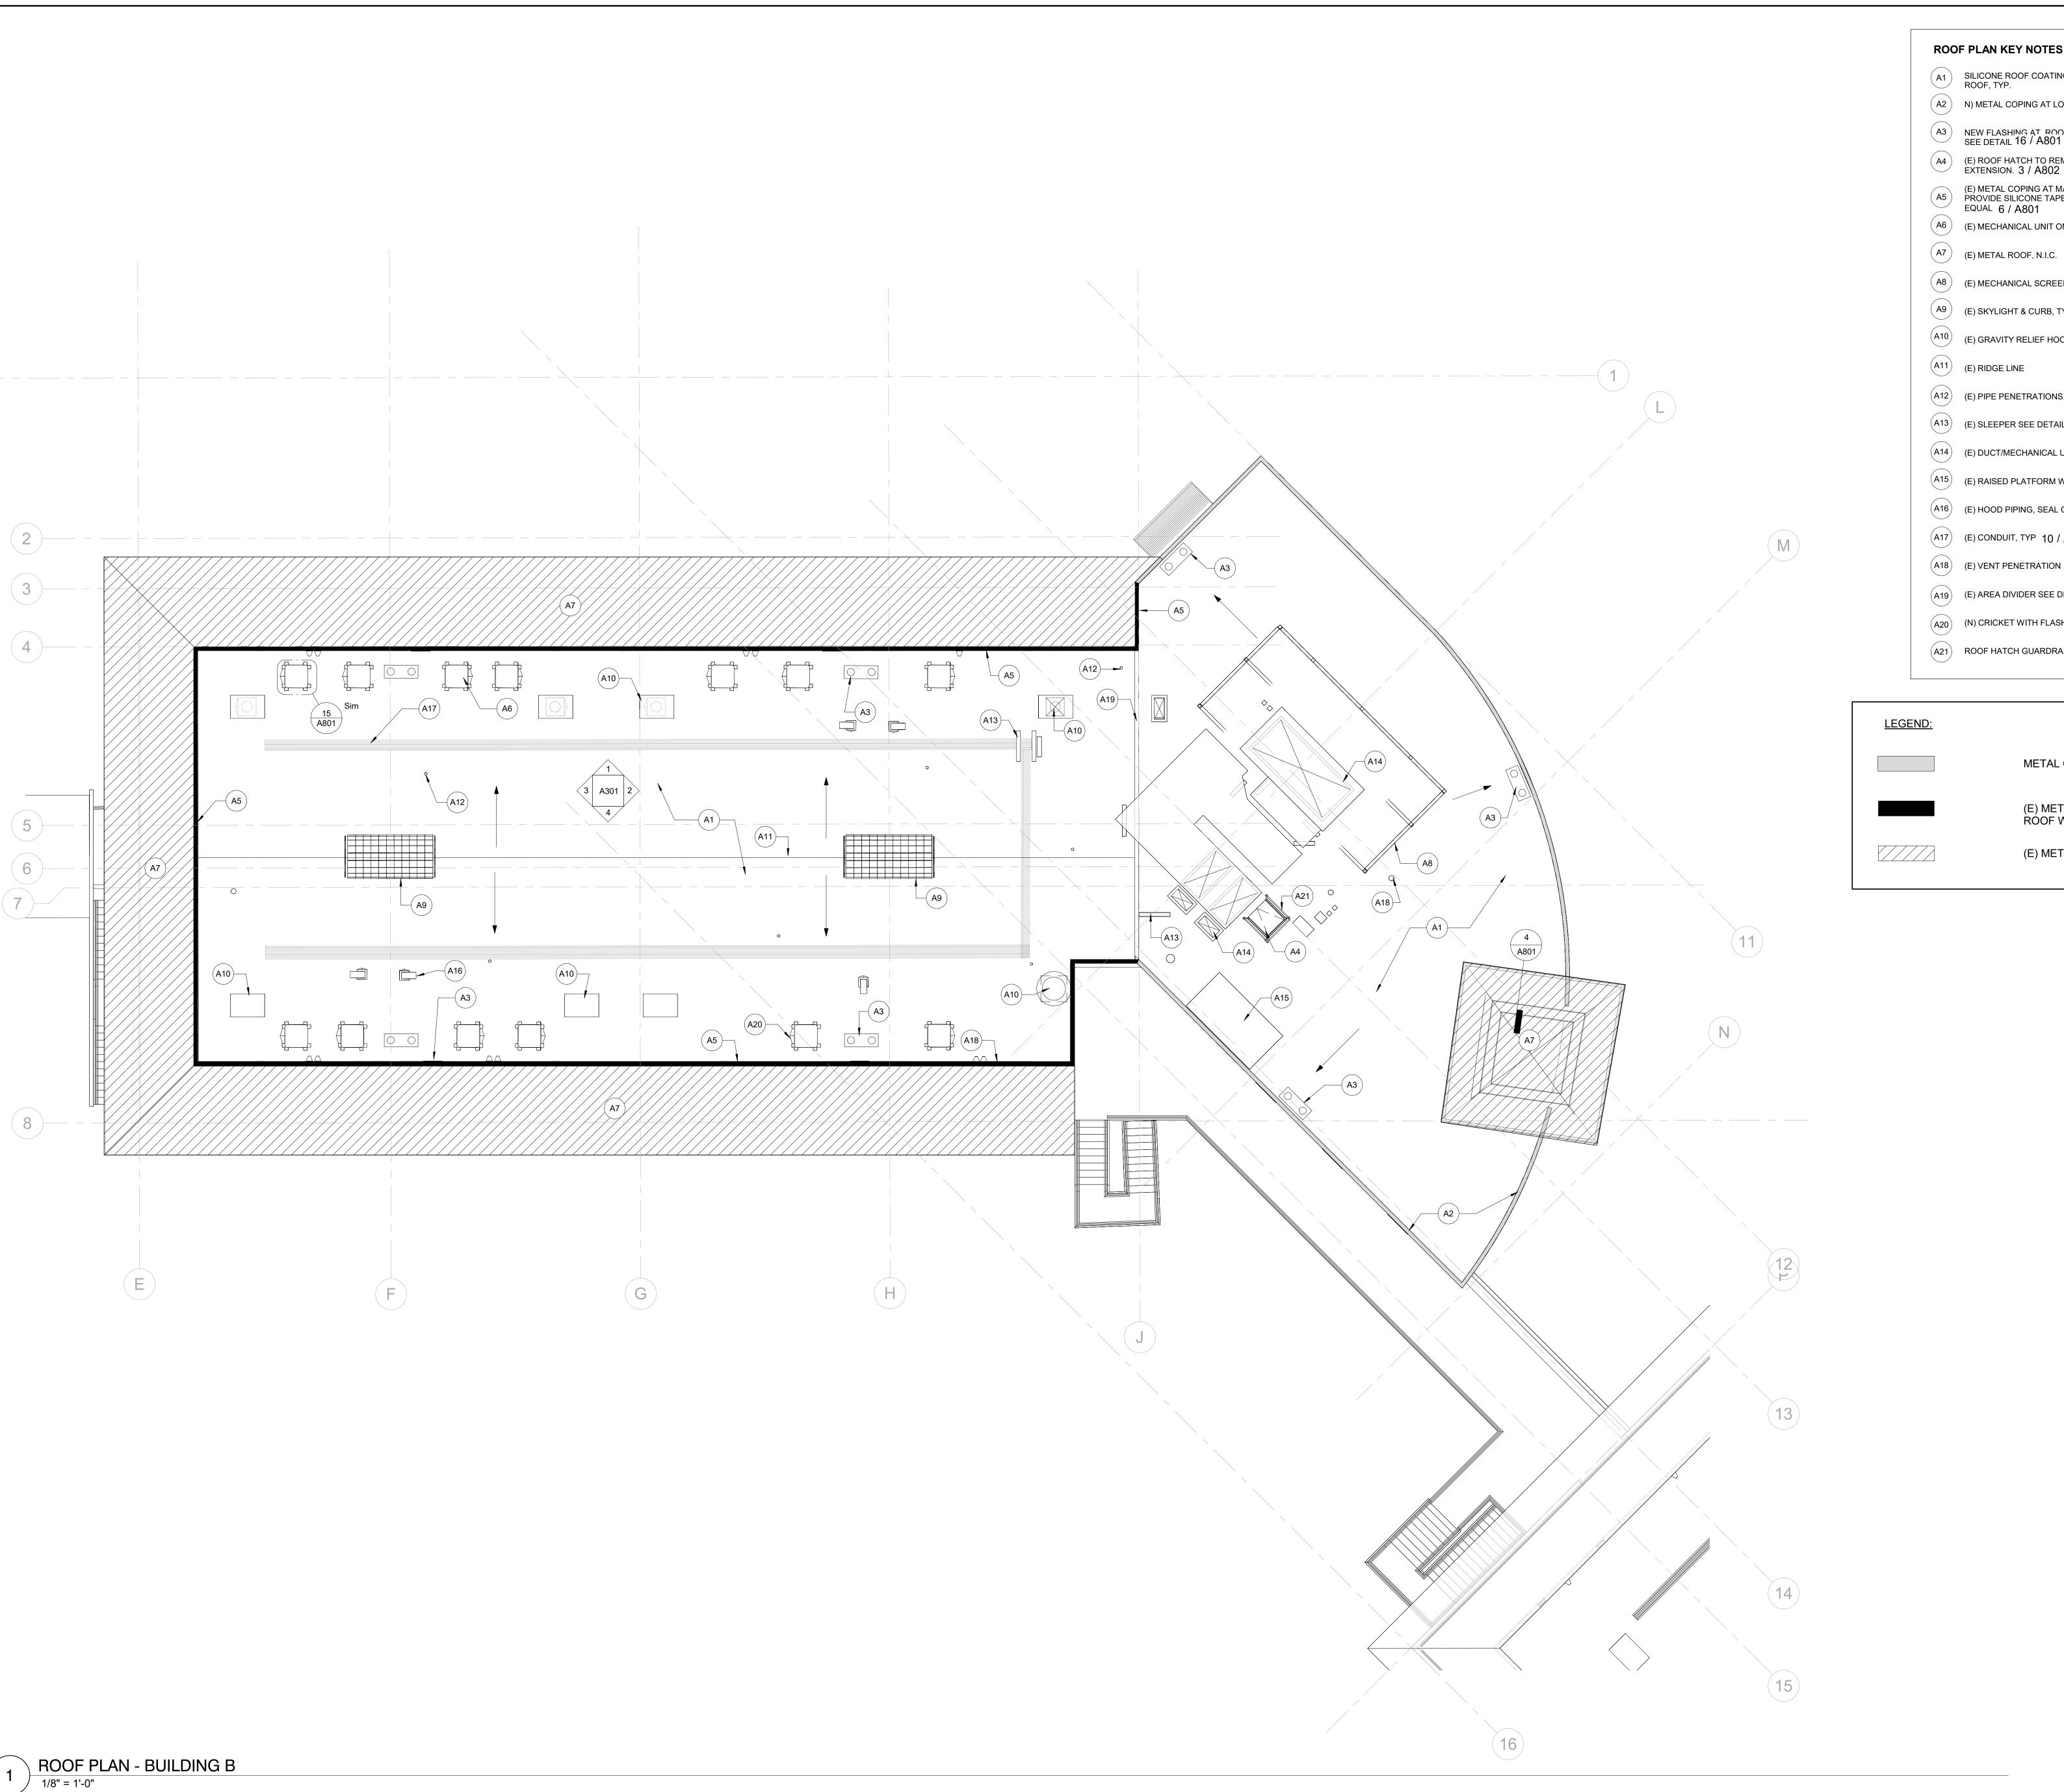

ROOF PLAN KEY NOTES - BUILDING B

- SILICONE ROOF COATING OVER ENTIRE (E) LOW SLOPED ROOF, TYP.
- (A2) N) METAL COPING AT LOW PARAPET 1 / A801
- NEW FLASHING AT ROOF AND OVERFLOW DRAINS, TYP. SEE DETAIL 16 / A801
- (E) ROOF HATCH TO REMAIN. REMOVE (E) LADDER EXTENSION. 3 / A802
- (E) METAL COPING AT MANSARD ROOF WALL TO REMAIN; PROVIDE SILICONE TAPE SEAL AT ALL JOINTS, DOW 123 OR EQUAL 6 / A801
- (E) MECHANICAL UNIT ON SLEEPER, TYP. 11 / A801
- (A8) (E) MECHANICAL SCREEN FRAME 5 / A802
- (A9) (E) SKYLIGHT & CURB, TYP 9 / A801
- (A10) (E) GRAVITY RELIEF HOOD AND CURB, TYP 13 / A801
- (A12) (E) PIPE PENETRATIONS, TYP. 14 / A801
- (A13) (E) SLEEPER SEE DETAIL 11 / A801 SIM
- (A14) (E) DUCT/MECHANICAL UNIT ON CURB, TYP 13 / A801
- (A15) (E) RAISED PLATFORM WITH (N) SILICONE ROOF COATING
- (A16) (E) HOOD PIPING, SEAL OPENING AROUND PIPES 13 / A801
- (A17) (E) CONDUIT, TYP 10 / A801
- (A18) (E) VENT PENETRATION 5 / A801
- (A₁₉) (E) AREA DIVIDER SEE DETAIL 3 / A₈₀₁
- (A20) (N) CRICKET WITH FLASHING SEE 11 / A801
- (A21) ROOF HATCH GUARDRAIL, TYP SEE 2 / A802



REVISION DESCRIPTION

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ISSUED FOR BID

INITIAL DATE

METAL COPING AT LOW PARAPET

(E) METAL COPING AT MANSARD ROOF WALL TO REMAIN

(E) METAL ROOF, N.I.C.




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BAHIA VISTA **ELEMENTARY** SCHOOL -ROOFING **UPGRADE AND IMPROVEMENTS**

125 BAHIA WAY SAN RAFAEL, CA. 94901

SHEET TITLE:

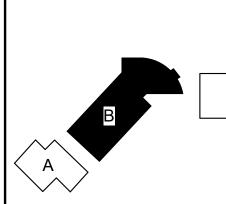


NORTH

ROOF PLAN -BUILDING B

PROJ. NO. 2020-036-01 PREPARATION AND REVIEW PROJ MGR: PEER REVIEW Checker

SHEET NUMBER:

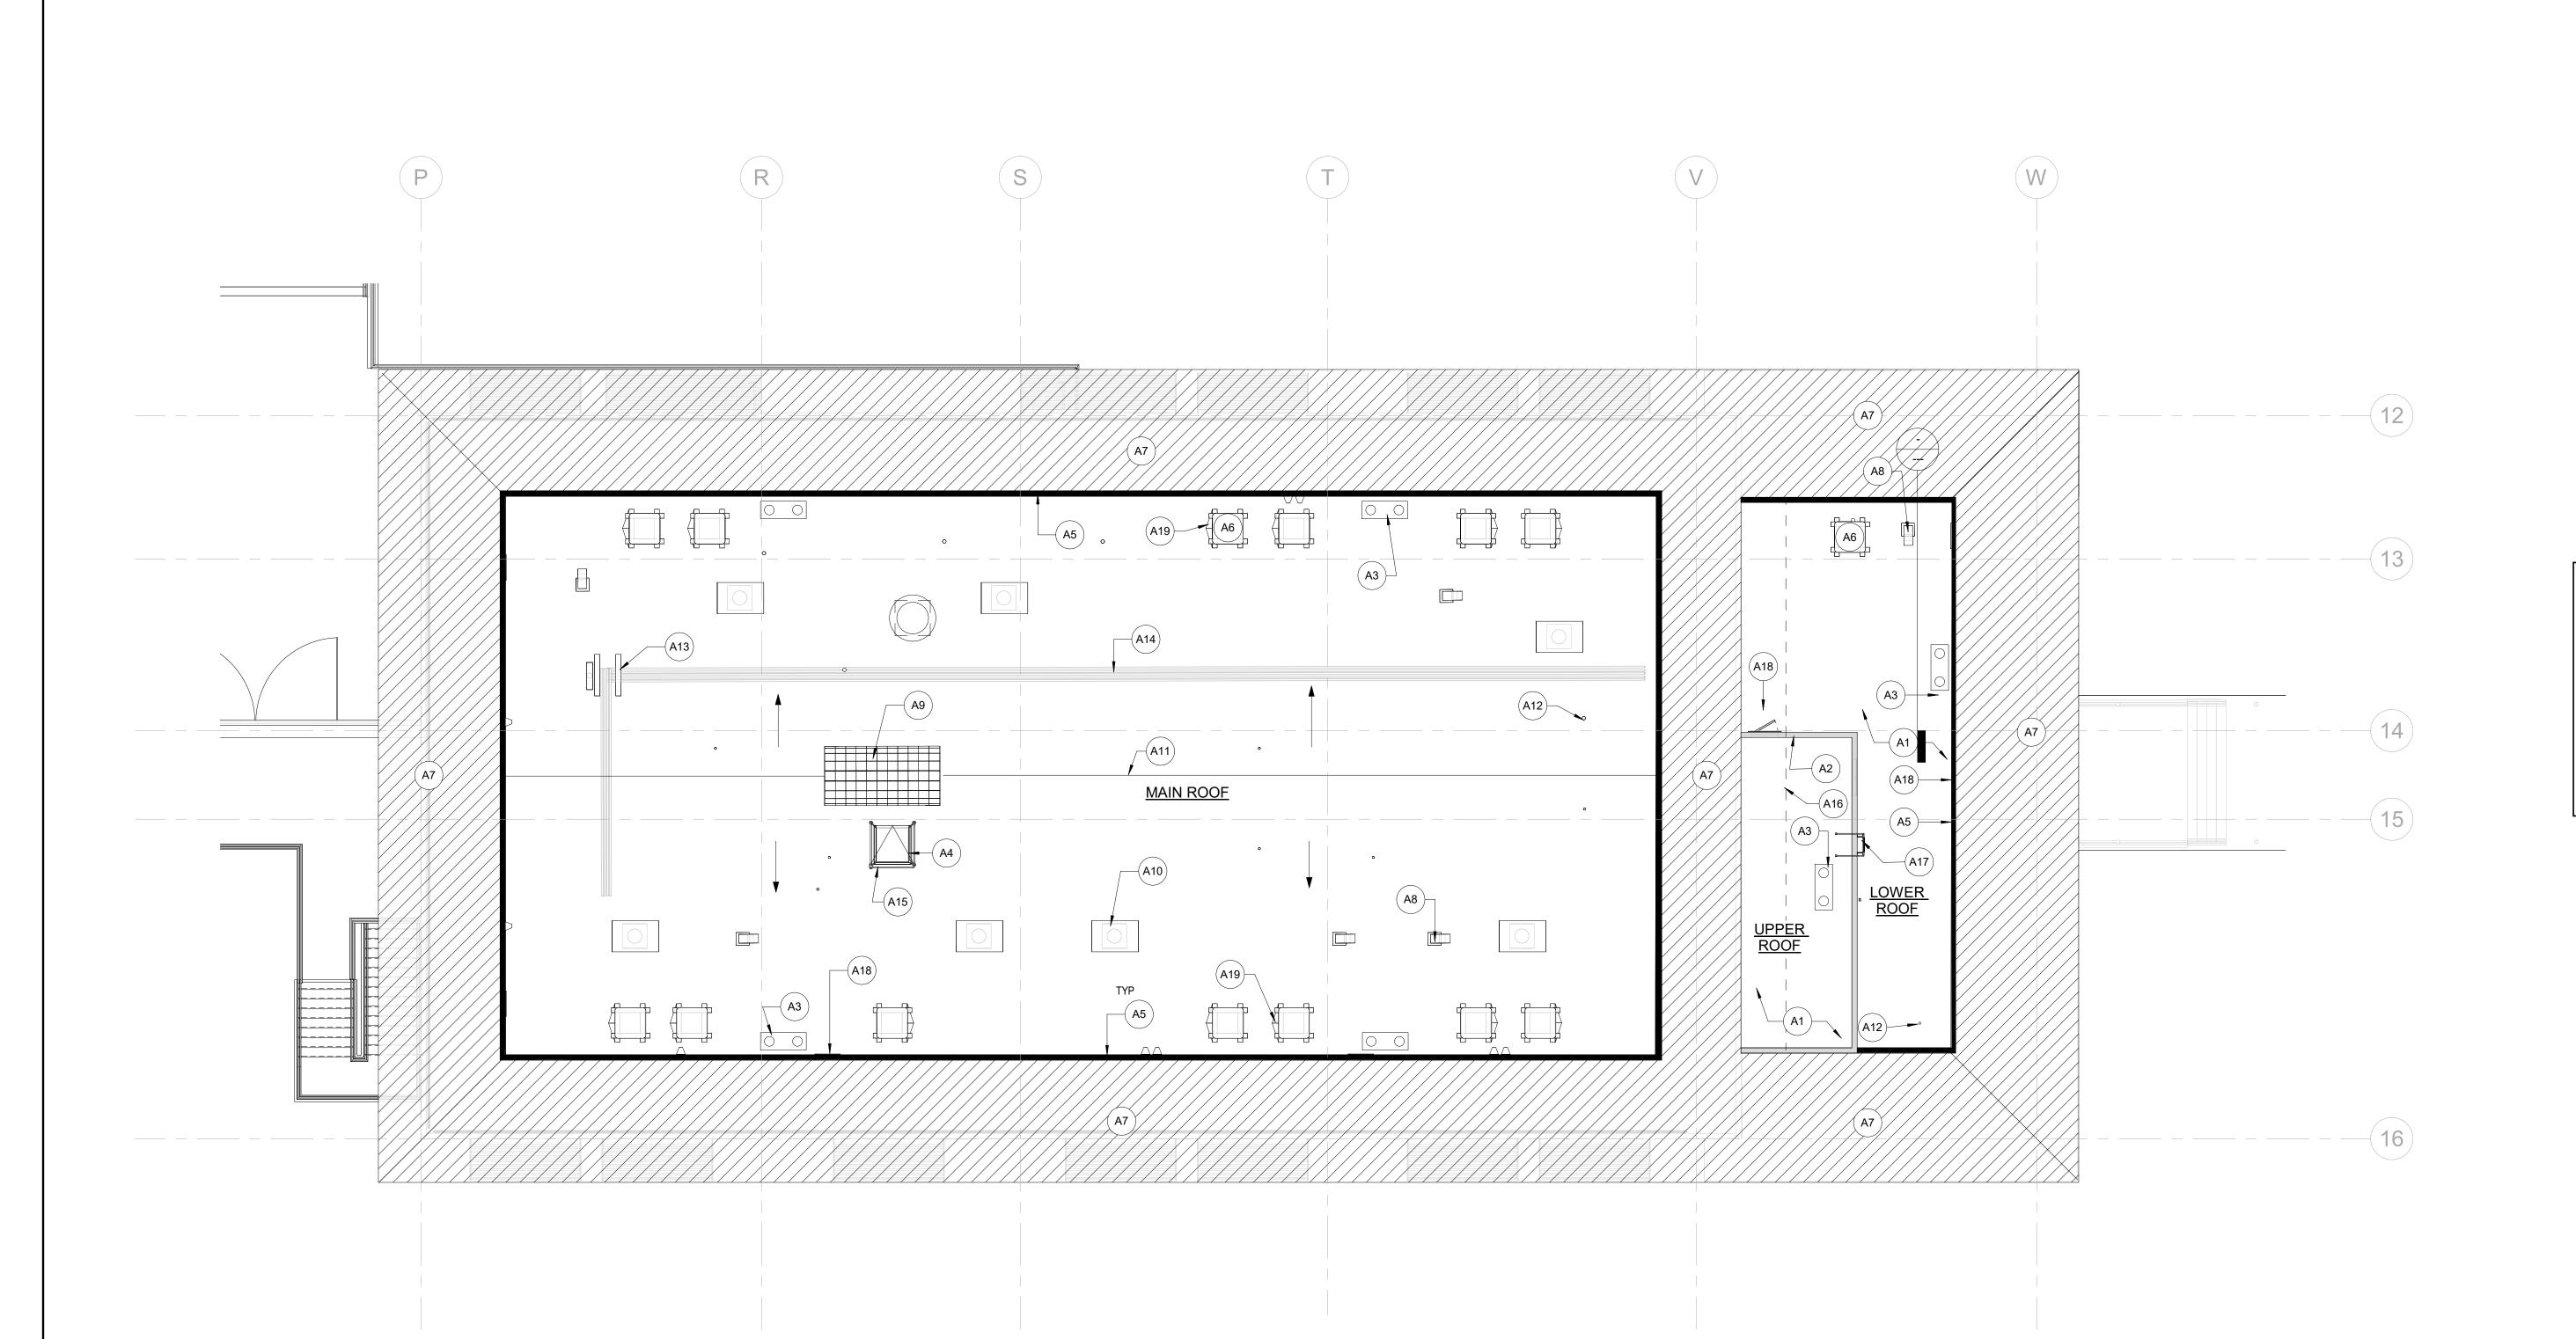

ROOF PLAN KEY NOTES - BUILDING C

- A1 SILICONE ROOF COATING OVER ENTIRE (E) LOW SLOPED ROOF, TYP.
- (A2) (N) METAL COPING AT LOW PARAPET 2 / A801
- (N) FLASHING AT (E) ROOF AND OVERFLOW DRAINS, TYP.16 / A801
- (E) ROOF HATCH TO REMAIN. REMOVE (E) LADDER EXTENSION. 3 / A802
- (E) METAL COPING AT MANSARD ROOF WALL TO REMAIN; PROVIDE SILICONE TAPE SEAL AT ALL JOINTS, DOW 123 OR EQUAL 6 / A801
- (E) MECHANICAL UNIT ON SLEEPER, TYP. 11 / A801
- (E) METAL ROOF, N.I.C.
- (E) HOOD PIPING, SEAL OPENING AROUND PIPES 13 / A801
- (E) SKYLIGHT & CURB. 13 / A801
- (E) GRAVITY RELIEF HOOD AND CURB, TYP 13 / A801
- (A11) (E) RIDGE LINE
- (A₁₂) (E) PIPE PENETRATIONS, TYP. 14 / A801
- (A13) (E) SLEEPER 11 / A801
- (A14) (E) CONDUIT, TYP 10 / A801
- (A15) ROOF HATCH GUARDRAIL 2 / A802
- (A16) LINE OF (E) ROOF ABOVE
- (A17) (E) ROOF ACCESS LADDER
- (A18) (E) DOOR 11 / A801 SIM

LEGEND:

(A19) (N) CRICKET WITH FLASHING, SEE 1 / A801



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ISSUED FOR PERMIT ISSUED FOR BID

INITIAL DATE


(E) METAL COPING AT MANSARD ROOF WALL TO REMAIN (E) METAL ROOF, N.I.C.

METAL COPING AT LOW PARAPET

BAHIA VISTA ELEMENTARY SCHOOL -ROOFING **UPGRADE AND IMPROVEMENTS**

125 BAHIA WAY SAN RAFAEL, CA. 94901

KEY PLAN

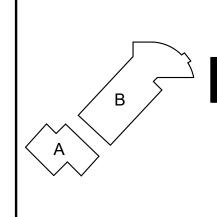



NORTH

SHEET TITLE: **ROOF PLAN -BUILDING C**

PROJ. NO. 2020-036-01 PREPARATION AND REVIEW DESIGNER: PROJ MGR: PEER REVIEW Checker SHEET NUMBER:


ROOF PLAN - BUILDING C

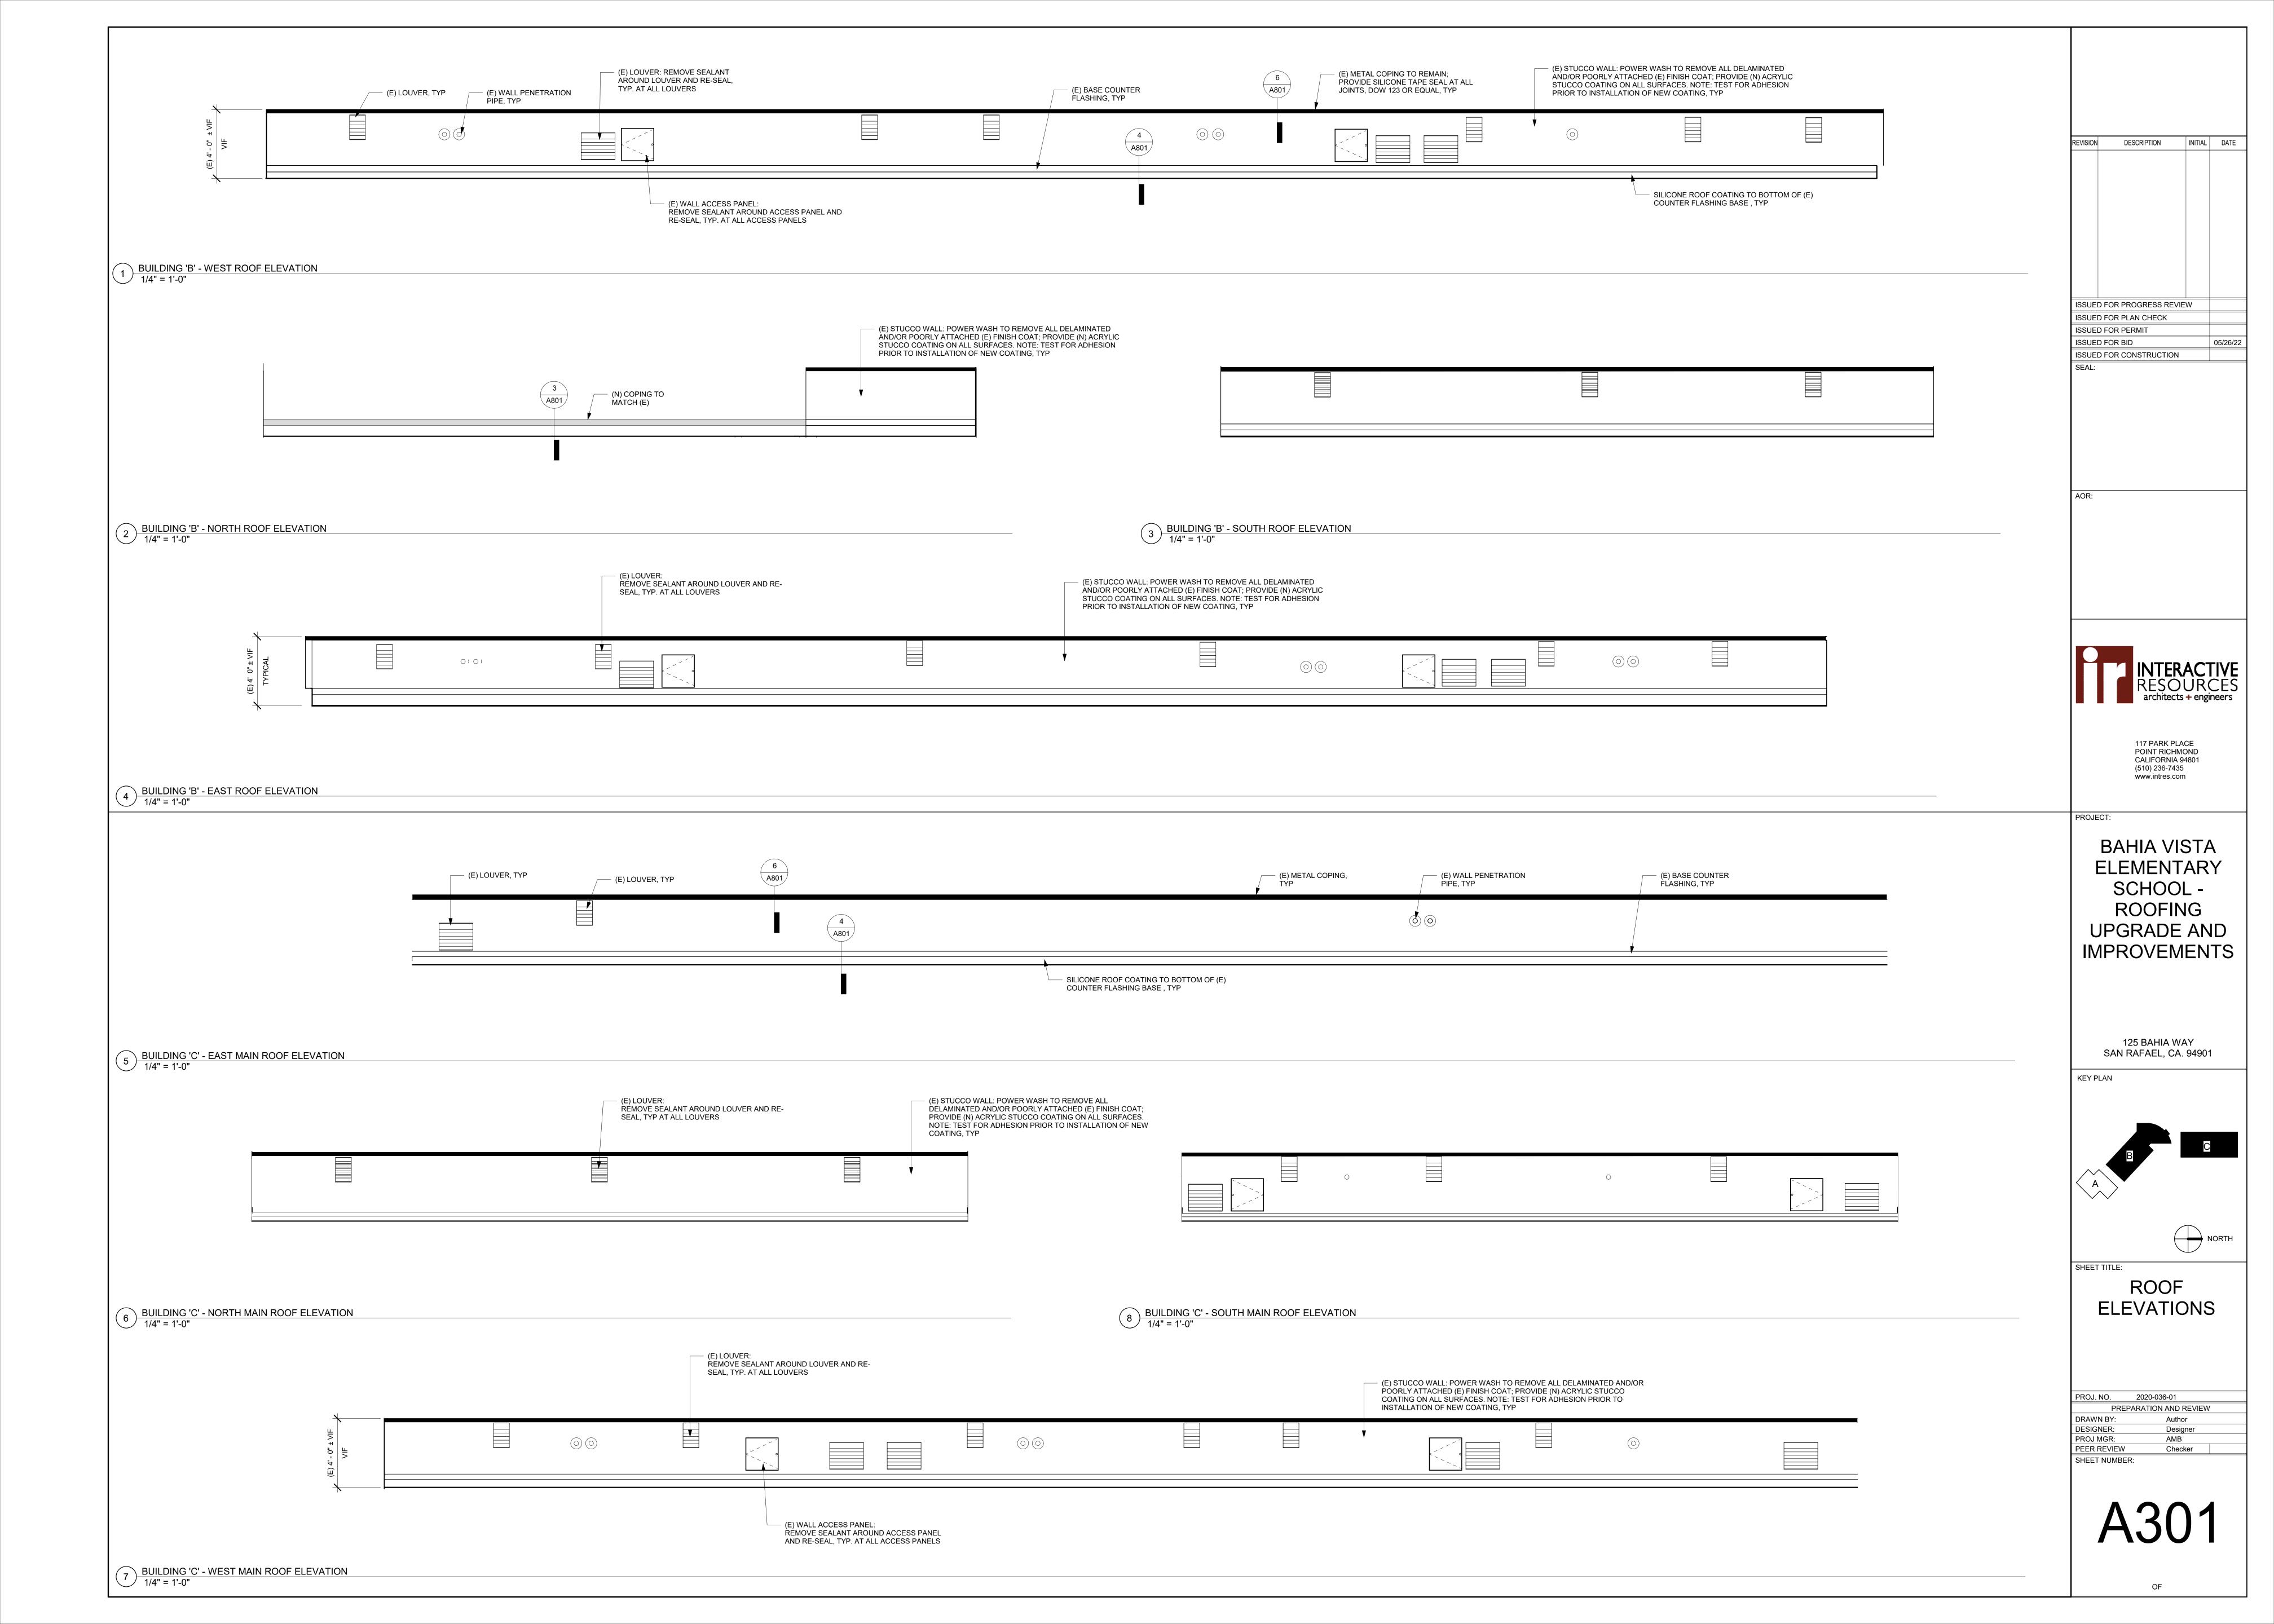

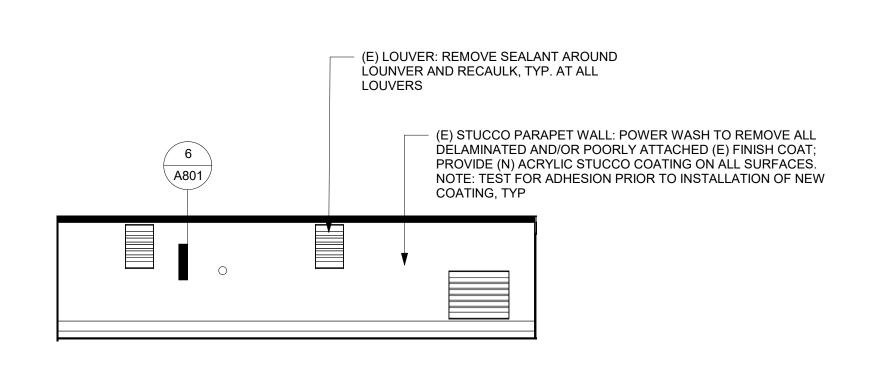

BUILDING 'C' - WEST LOWER ROOF ELEVATION

1/4" = 1'-0"

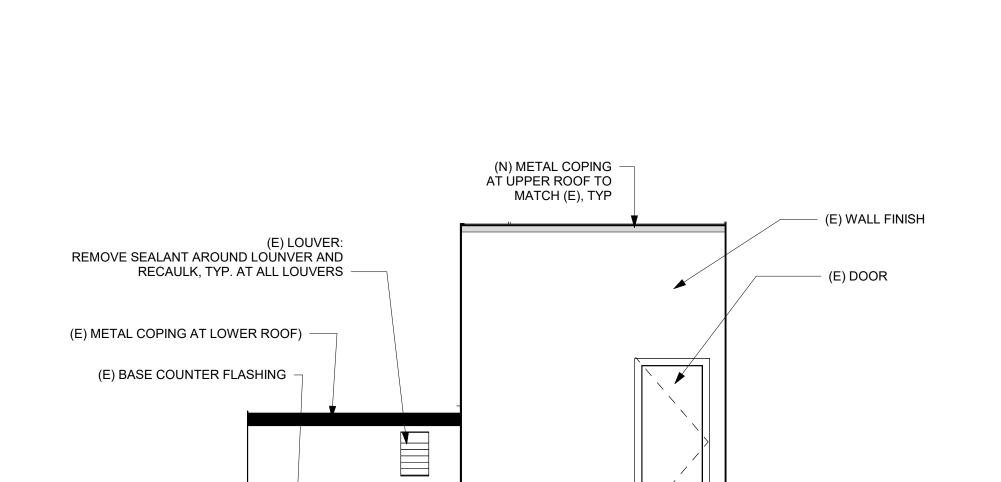



 SILICAONE ROOF COATING TO BOTTOM OF (E) COUNTER FLASHING BASE, TYP

BUILDING 'C' - EAST LOWER ROOF ELEVATION

1/4" = 1'-0"


(E) WALL FINISH

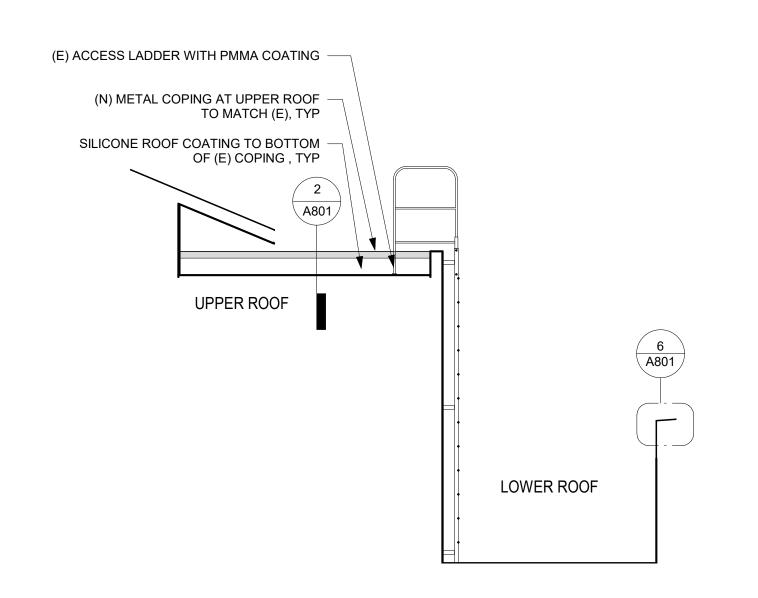

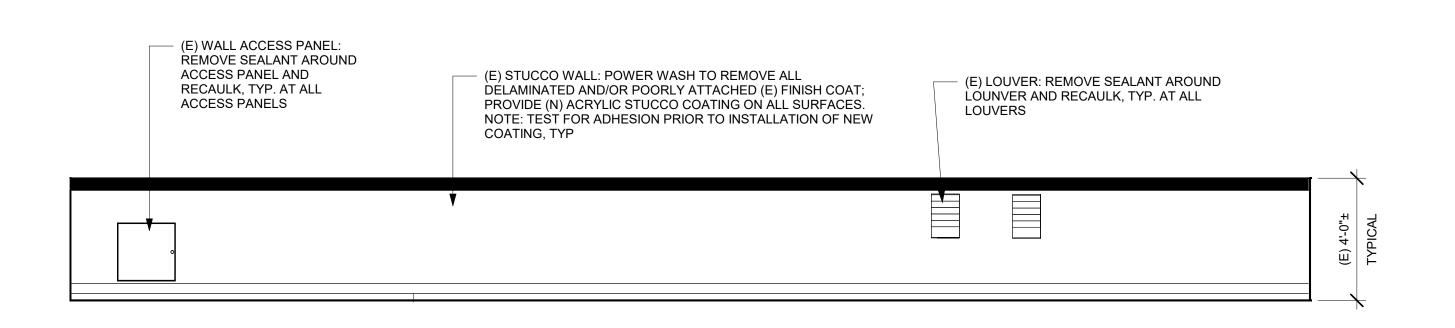


BUILDING 'C' - NORTH LOWER ROOF ELEVATION

1/4" = 1'-0"

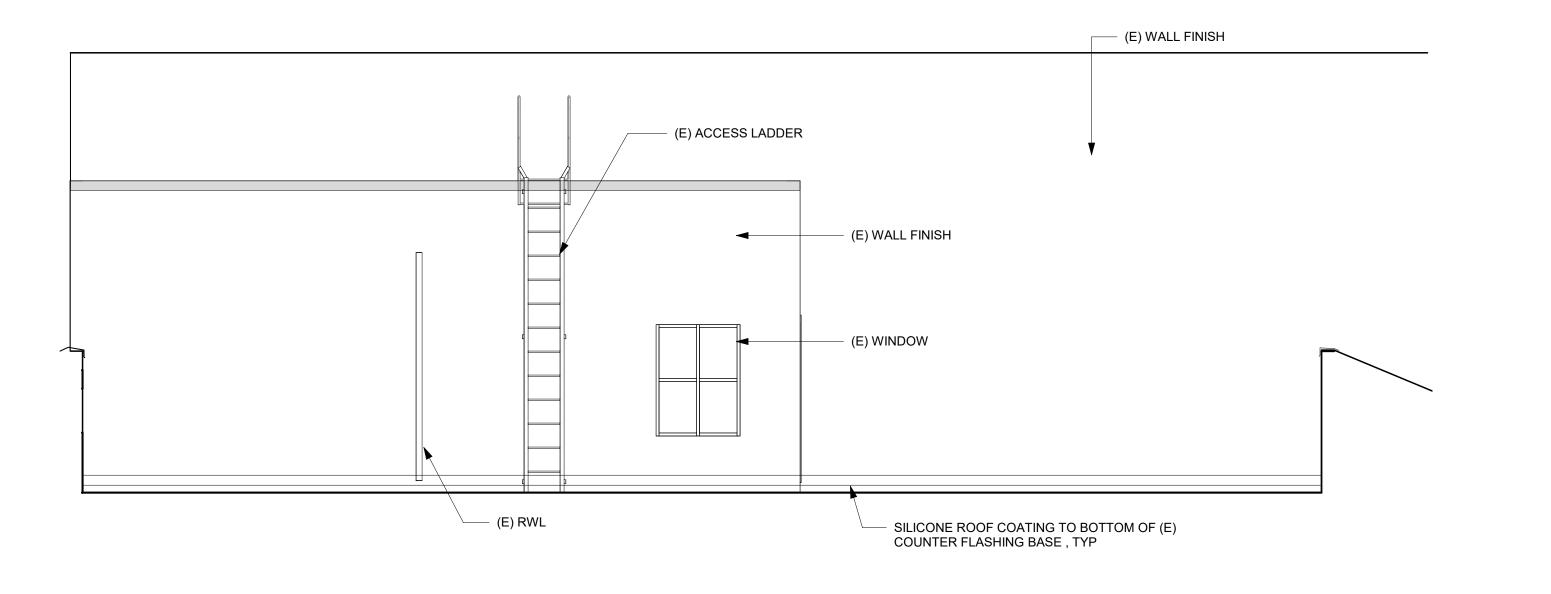

BUILDING 'C' - SOUTH LOWER ROOF ELEVATION

1/4" = 1'-0"

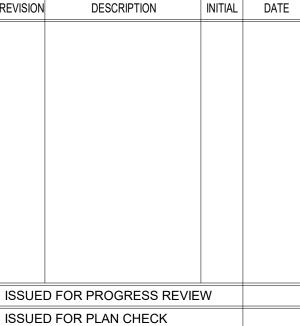

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ISSUED FOR PLAN CHECK
ISSUED FOR PERMIT
ISSUED FOR BID
ISSUED FOR CONSTRUCTION

AOR:

INTERACTIVE RESOURCES architects + engineers


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PROJECT:

BAHIA VISTA ELEMENTARY SCHOOL -ROOFING UPGRADE AND IMPROVEMENTS

> 125 BAHIA WAY SAN RAFAEL, CA. 94901

KEY PLAN

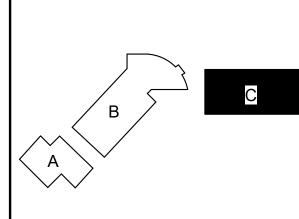

NORT

SHEET TITLE:

ROOF ELEVATIONS & SECTION

PROJ. NO. 2020-036-01

PREPARATION AND REVIEW

DRAWN BY: MT

DESIGNER: GYN

PROJ MGR: AMB

PEER REVIEW Checker

SHEET NUMBER:

A302

